


## First Floor



## Appendix 1


## Walls

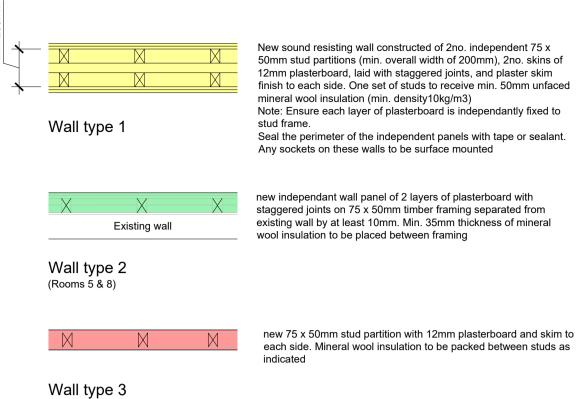


#### vvaii type 3

## Ceilings


All first floor areas to have suspended ceilings fitted. Existing ceilings/coving to be left untouched above.

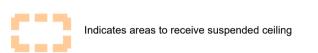

See detail below for acoustic measures to 2nd floors

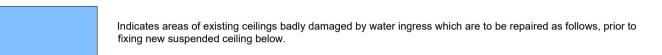

- 1. Hack off damaged plaster and underlying lathwork back to sound plaster, ensuring that laths are cut back to a structural support beam
- 2. Fix laths Oak Riven Laths allowing 25 no metre lengths per square metre.
- 3. Make sure surfaces are sound. Wet surfaces thoroughly. Dub out any large voids using Tradlym Mortar BM2. Allow dubbing out to cure.
- 4. First coat Wet surface thoroughly. Apply 1st backing coat of Tradlym Backing with Hair/Fibre to a maximum depth of 10mm. If application is to laths sufficient mortar must be pushed through the lath to form "hooks" to take the weight of the remaining mortar. Allow to cure (up to 10 days) misting occasionally if plaster starts to dry out. Scratch to receive 2nd coat.
- 5. Second coat Wet 1st coat. Apply 2nd coat of Tradlym Backing with Hair/Fibre and straighten up. Allow to cure again misting if necessary. Scratch with devil float.
- 6. Finish coat Wet 2nd coat. Apply Tradlym Fine Finish plaster to a maximum depth of 4mm.

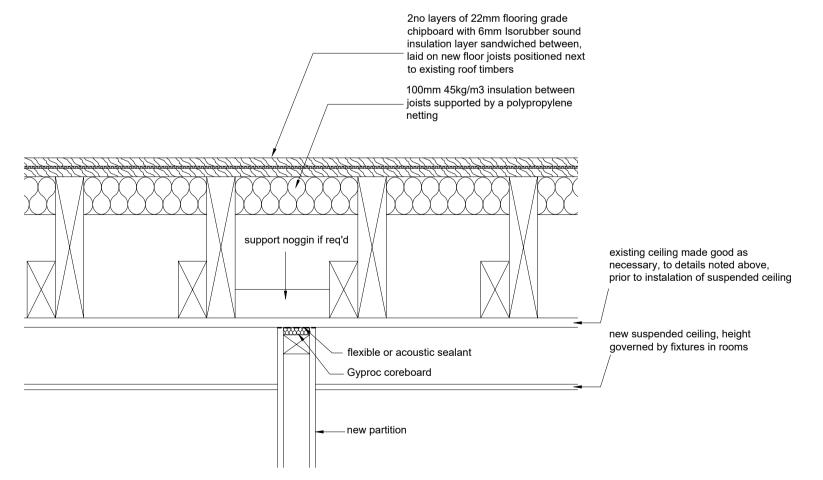

Scale 1:50 @ A1

# Section Through Existing Second Floor



## Oxon Planning Partnership EDEN HOUSE, TWO RIVERS BUSINESS PARK, STATION LANE,

WITNEY, OX28 4BL TEL. 01993 890760 FAX. 01993 779746


PROJECT:

CONVERSION OF OLD ABBEY HOUSE, ABINGDON


TITLE:

WORKING PLAN FIRST FLOOR (SHEET 1 OF 2)


DRAWN: <i>AR</i> 11/02/22	SCALE: 1:50
DRAWING No: AB7/P/13	REVISION:

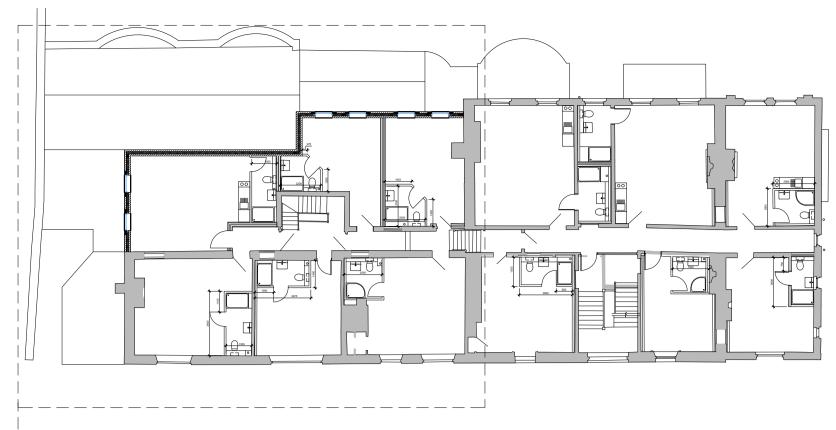

## First Floor

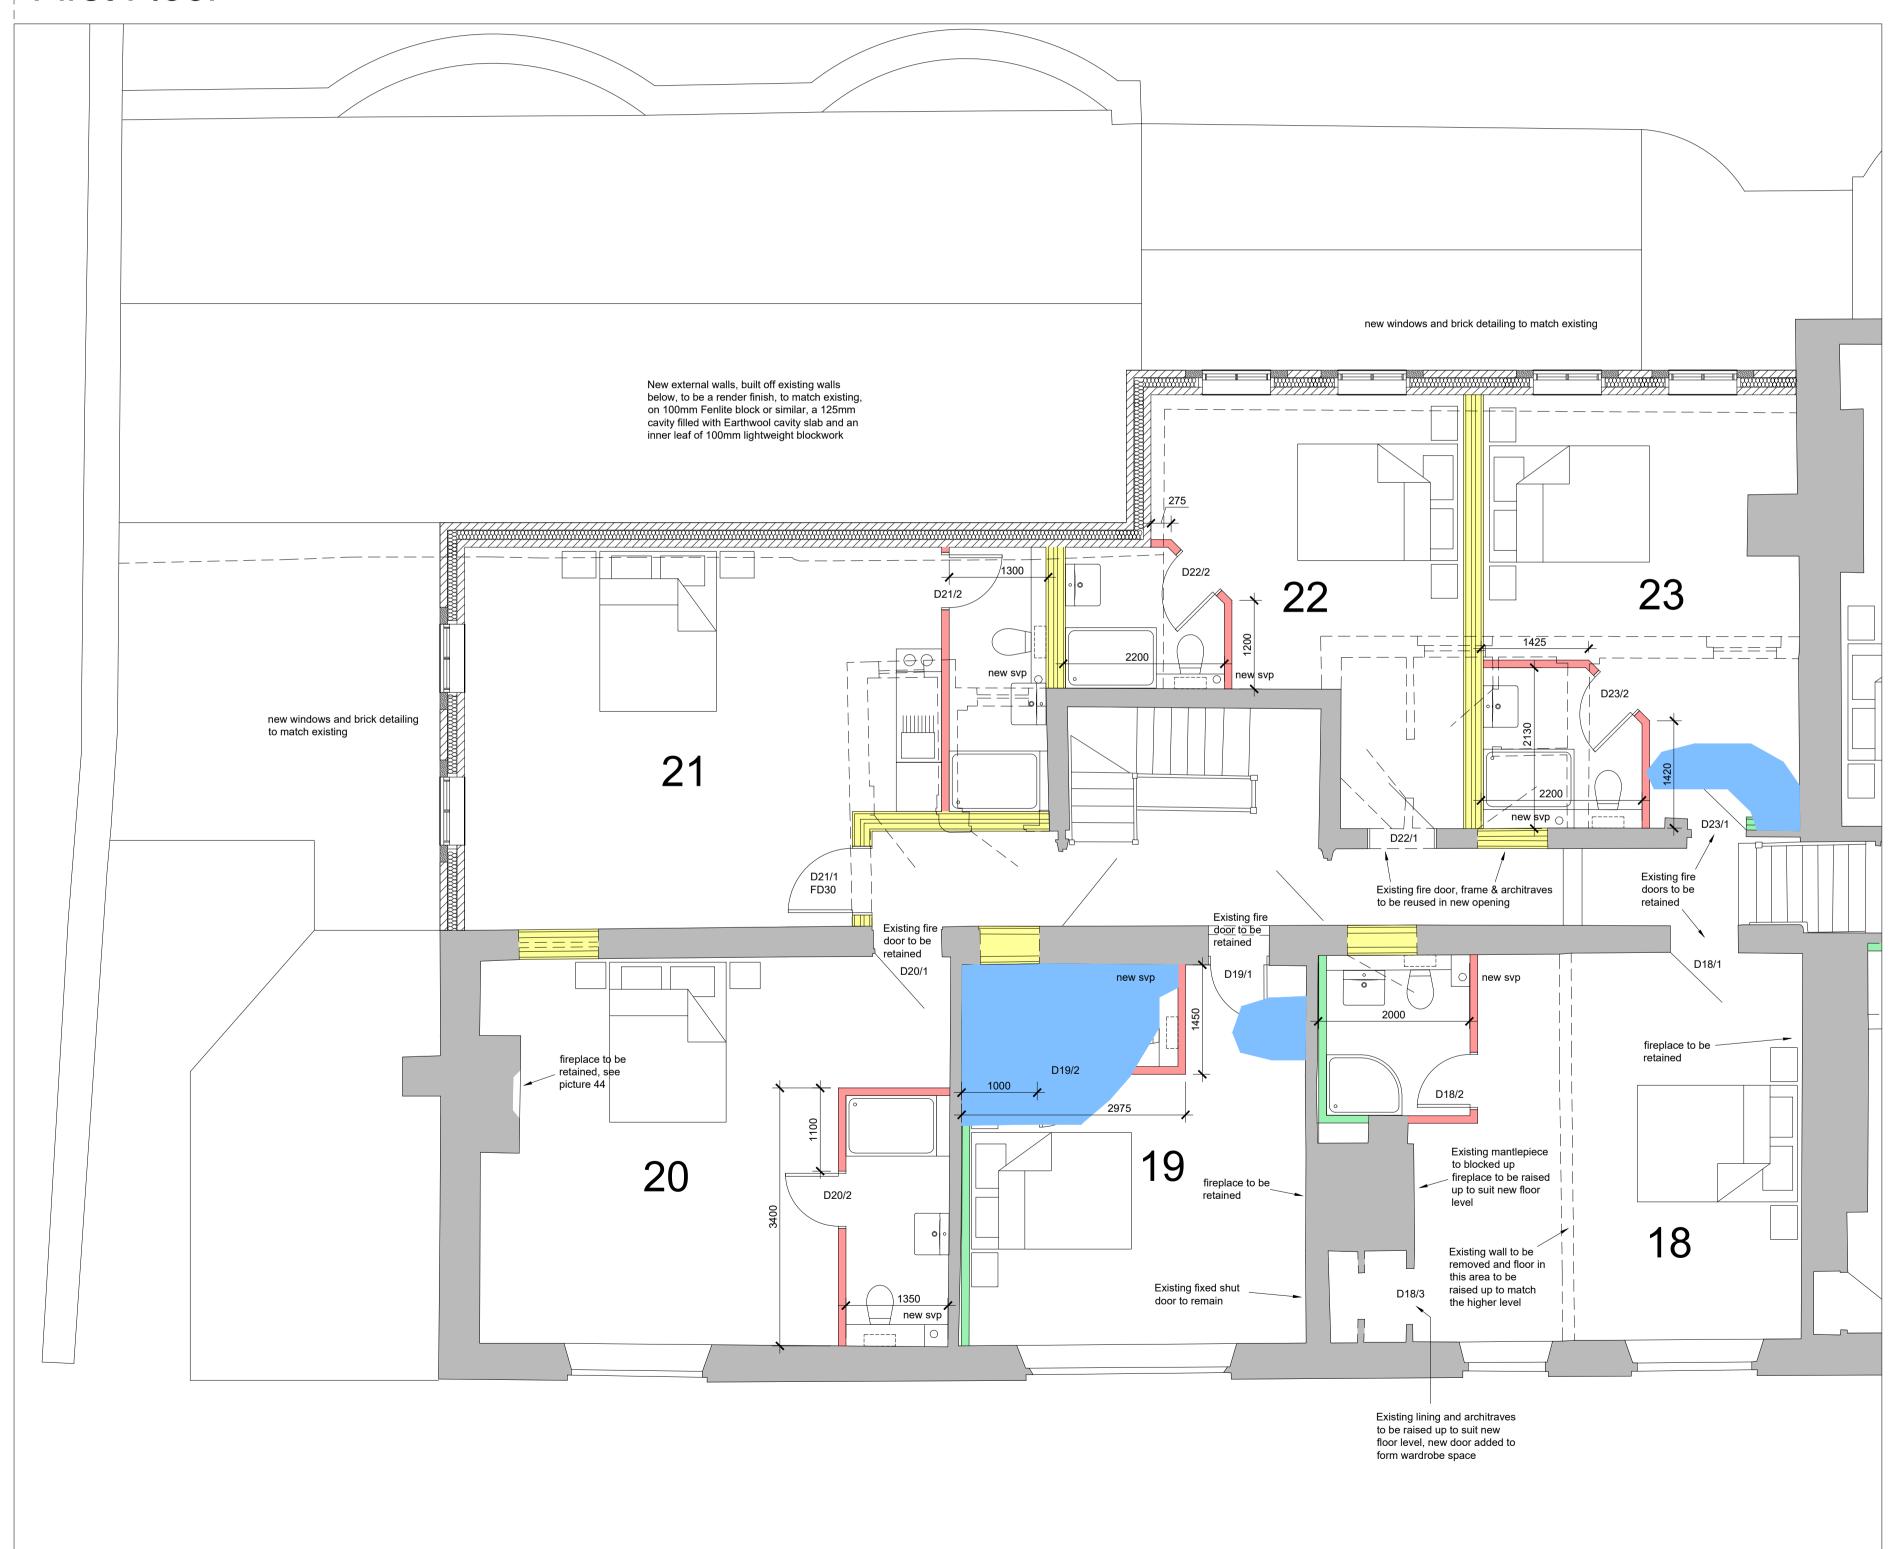


#### Walls

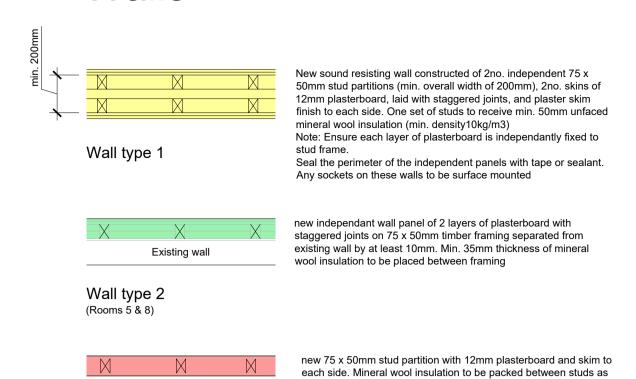

#### Wall type 3

## Ceilings

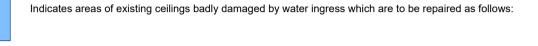

- 1. Hack off damaged plaster and underlying lathwork back to sound plaster, ensuring that laths are cut back to a structural support beam
- 2. Fix laths Oak Riven Laths allowing 25 no metre lengths per square metre.
- Make sure surfaces are sound. Wet surfaces thoroughly. Dub out any large voids using Tradlym Mortar BM2. Allow dubbing out to cure.
- 4. First coat Wet surface thoroughly. Apply 1st backing coat of Tradlym Backing with Hair/Fibre to a maximum depth of 10mm. If application is to laths sufficient mortar must be pushed through the lath to form "hooks" to take the weight of the remaining mortar. Allow to cure (up to 10 days) misting occasionally if plaster starts to dry out. Scratch to receive 2nd coat.
- Second coat Wet 1st coat. Apply 2nd coat of Tradlym Backing with Hair/Fibre and straighten up. Allow to cure again misting if necessary. Scratch with devil float.

6. Finish coat - Wet 2nd coat. Apply Tradlym Fine Finish plaster to a maximum depth of 4mm.




## Oxon Planning Partnership EDEN HOUSE, TWO RIVERS BUSINESS PARK, STATION LANE, WITNEY, OX28 4BL TEL. 01993 890760 FAX. 01993 779746

PROJECT:


CONVERSION OF OLD ABBEY HOUSE, ABINGDON

TITLE:


WORKING PLAN GROUND FLOOR (SHEET 2 OF 2)

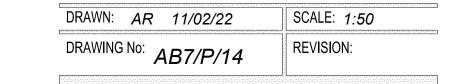




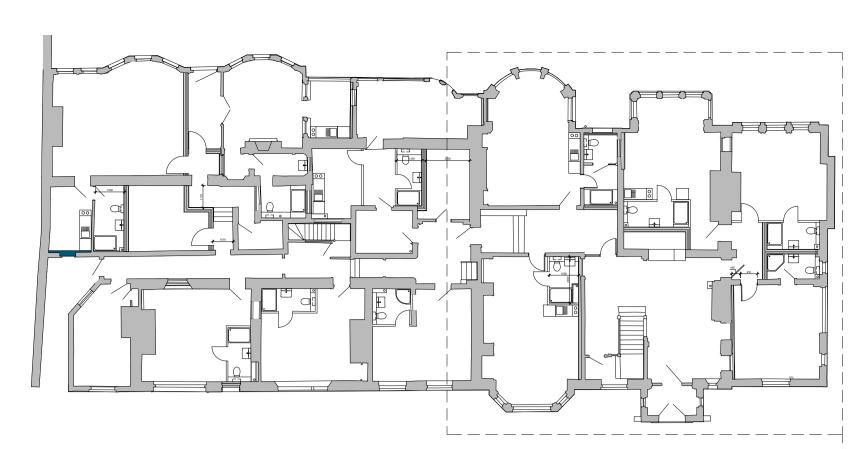

## **Ground Floor**

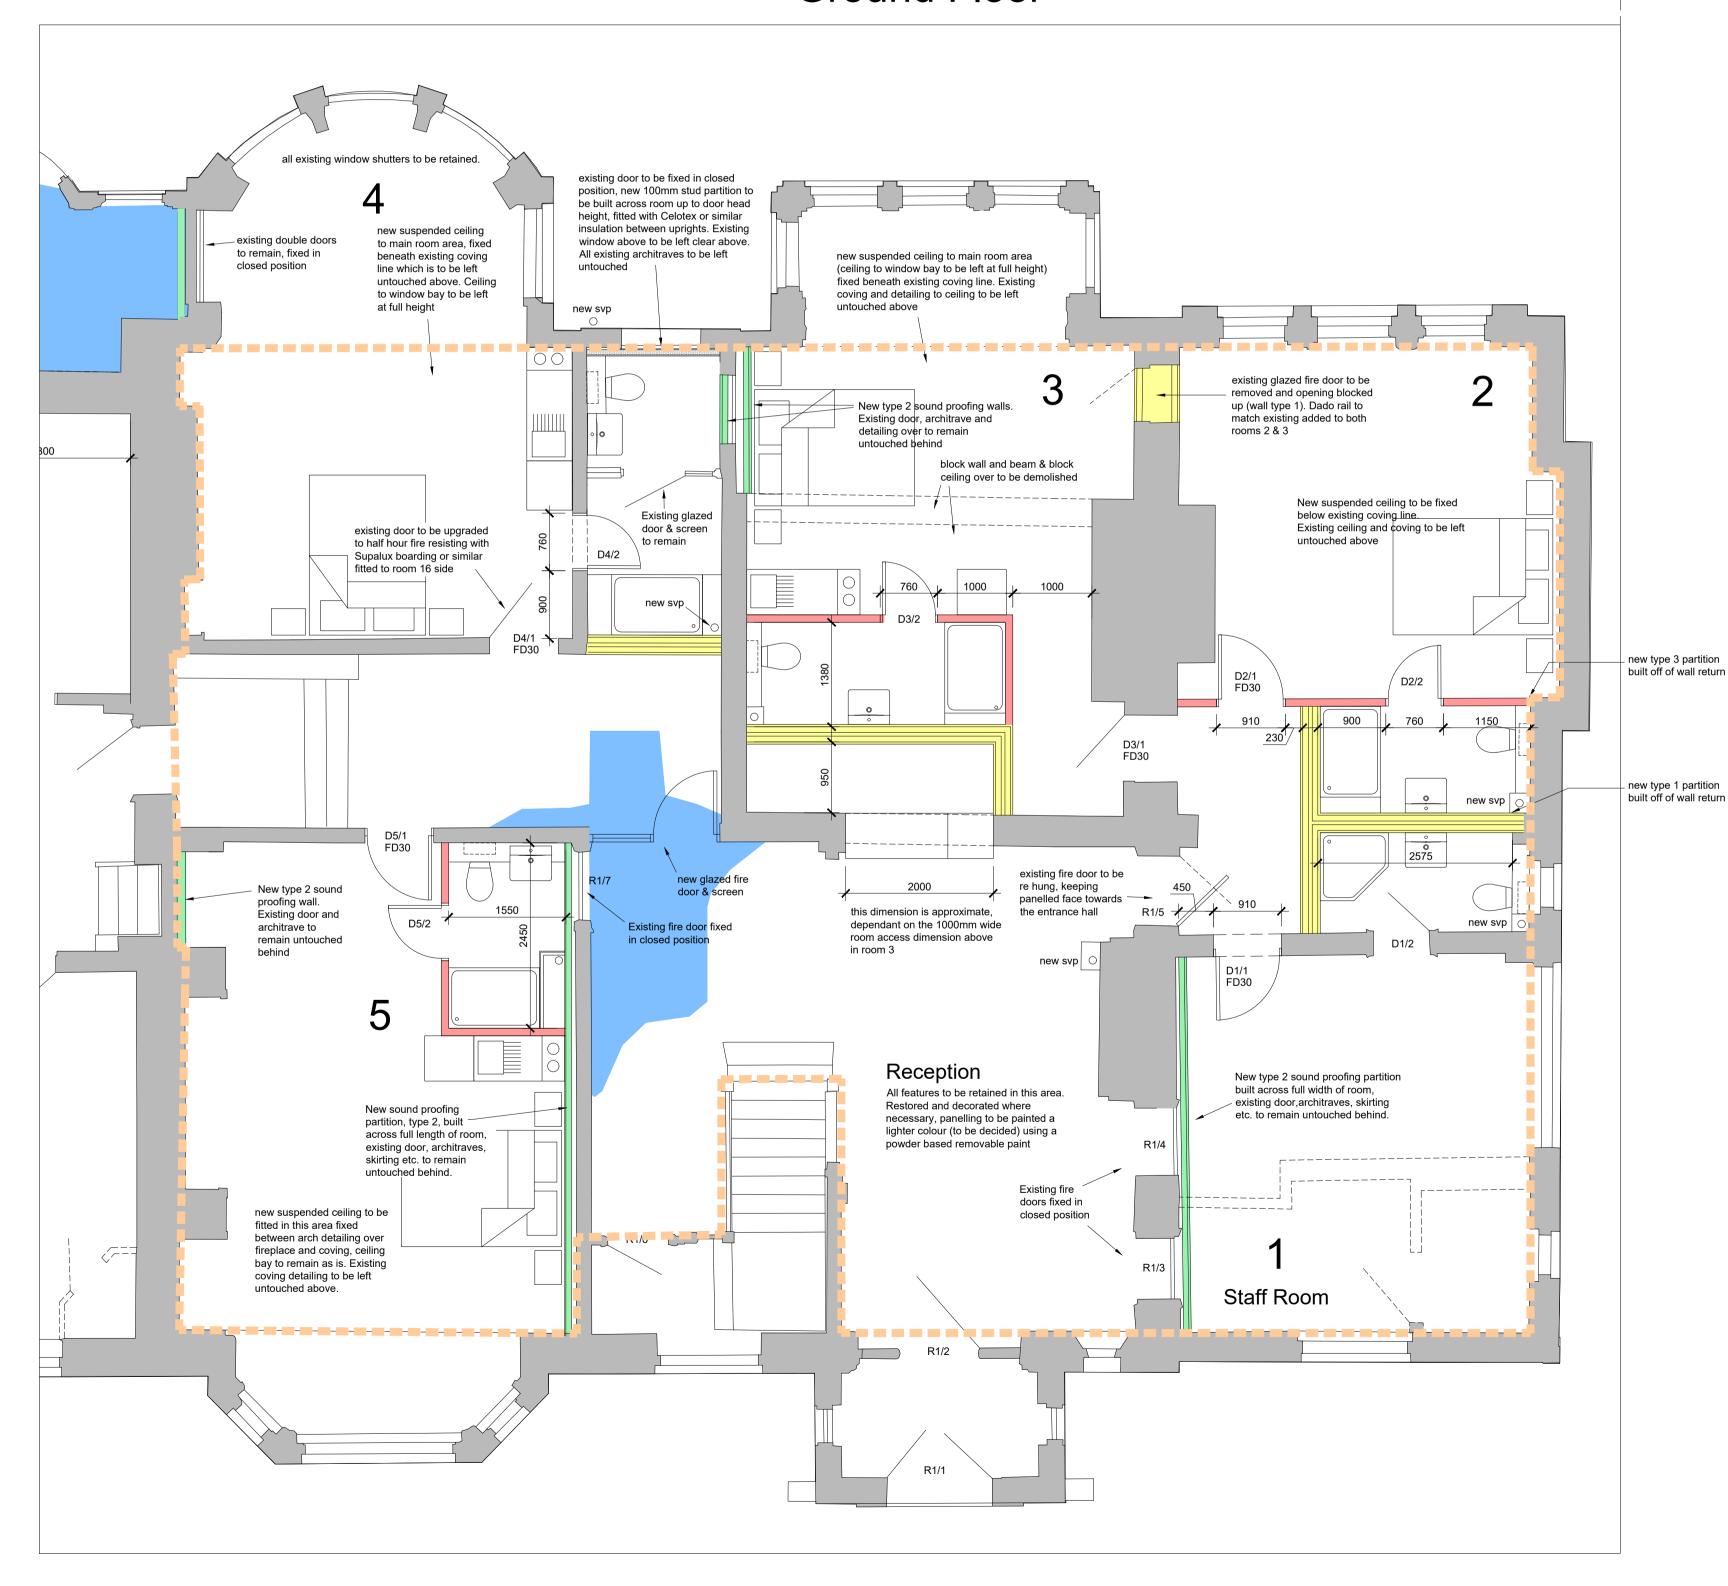


#### Walls

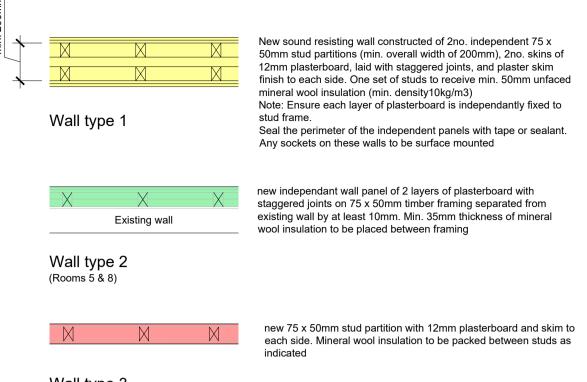


#### Wall type 3

## Ceilings


All ground floor areas to have suspended ceilings fitted, apart from bays as noted on plan. Existing ceilings/coving to be left untouched above.

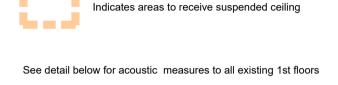

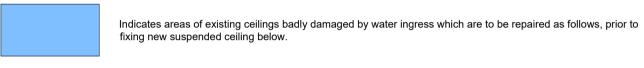

- Hack off damaged plaster and underlying lathwork back to sound plaster, ensuring that laths are cut back to a structural support beam
- 2. Fix laths Oak Riven Laths allowing 25 no metre lengths per square metre.
- 3. Make sure surfaces are sound. Wet surfaces thoroughly. Dub out any large voids using Tradlym Mortar BM2. Allow dubbing out to cure.
- 4. First coat Wet surface thoroughly. Apply 1st backing coat of Tradlym Backing with Hair/Fibre to a maximum depth of 10mm. If application is to laths sufficient mortar must be pushed through the lath to form "hooks" to take the weight of the remaining mortar. Allow to cure (up to 10 days) misting occasionally if plaster starts to dry out. Scratch to receive 2nd coat.
- 5. Second coat Wet 1st coat. Apply 2nd coat of Tradlym Backing with Hair/Fibre and straighten up. Allow to cure again misting if necessary. Scratch with devil float.

6. Finish coat - Wet 2nd coat. Apply Tradlym Fine Finish plaster to a maximum depth of 4mm.

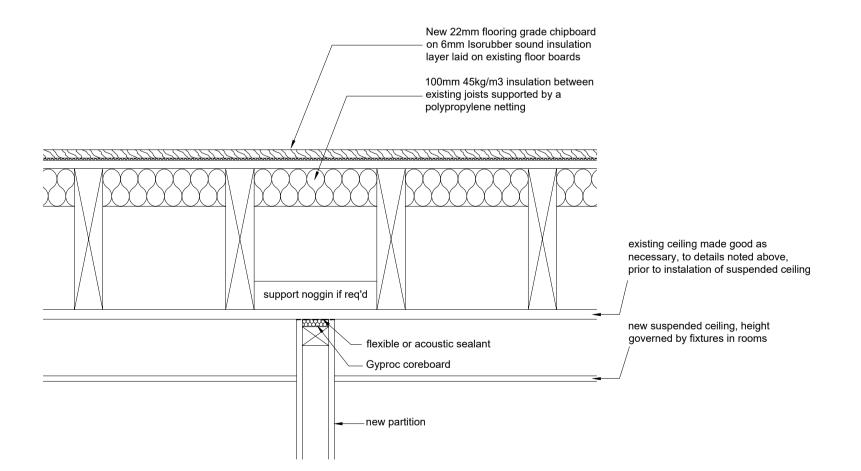

Scale 1:50 @ A1

## Section Through Existing First Floor



## Oxon Planning Partnership EDEN HOUSE, TWO RIVERS BUSINESS PARK, STATION LANE,

WITNEY, OX28 4BL TEL. 01993 890760 FAX. 01993 779746


PROJECT:

CONVERSION OF OLD ABBEY HOUSE, ABINGDON

TITLE:


WORKING PLAN GROUND FLOOR (SHEET 1 OF 2)

DRAWN: <i>AR</i> 11/02/22	SCALE: 1:50
DRAWING No: AB7/P/11	REVISION:

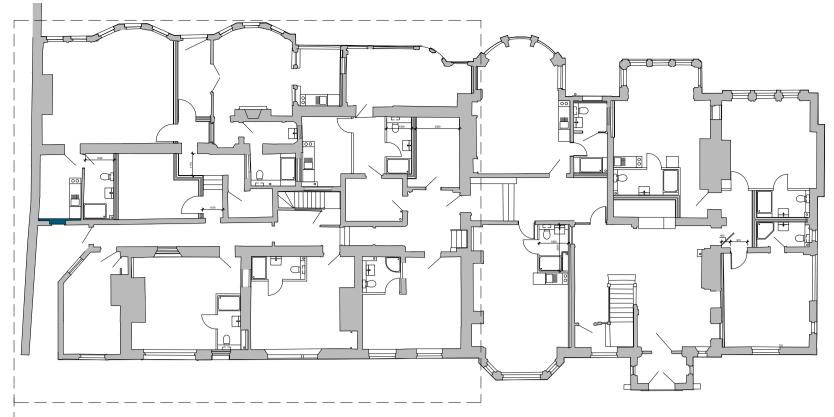


**Ground Floor** 

All ground floor glazing on the East elevation to be fitted with opaque film internally to a height of 1800mm for privacy from public gardens

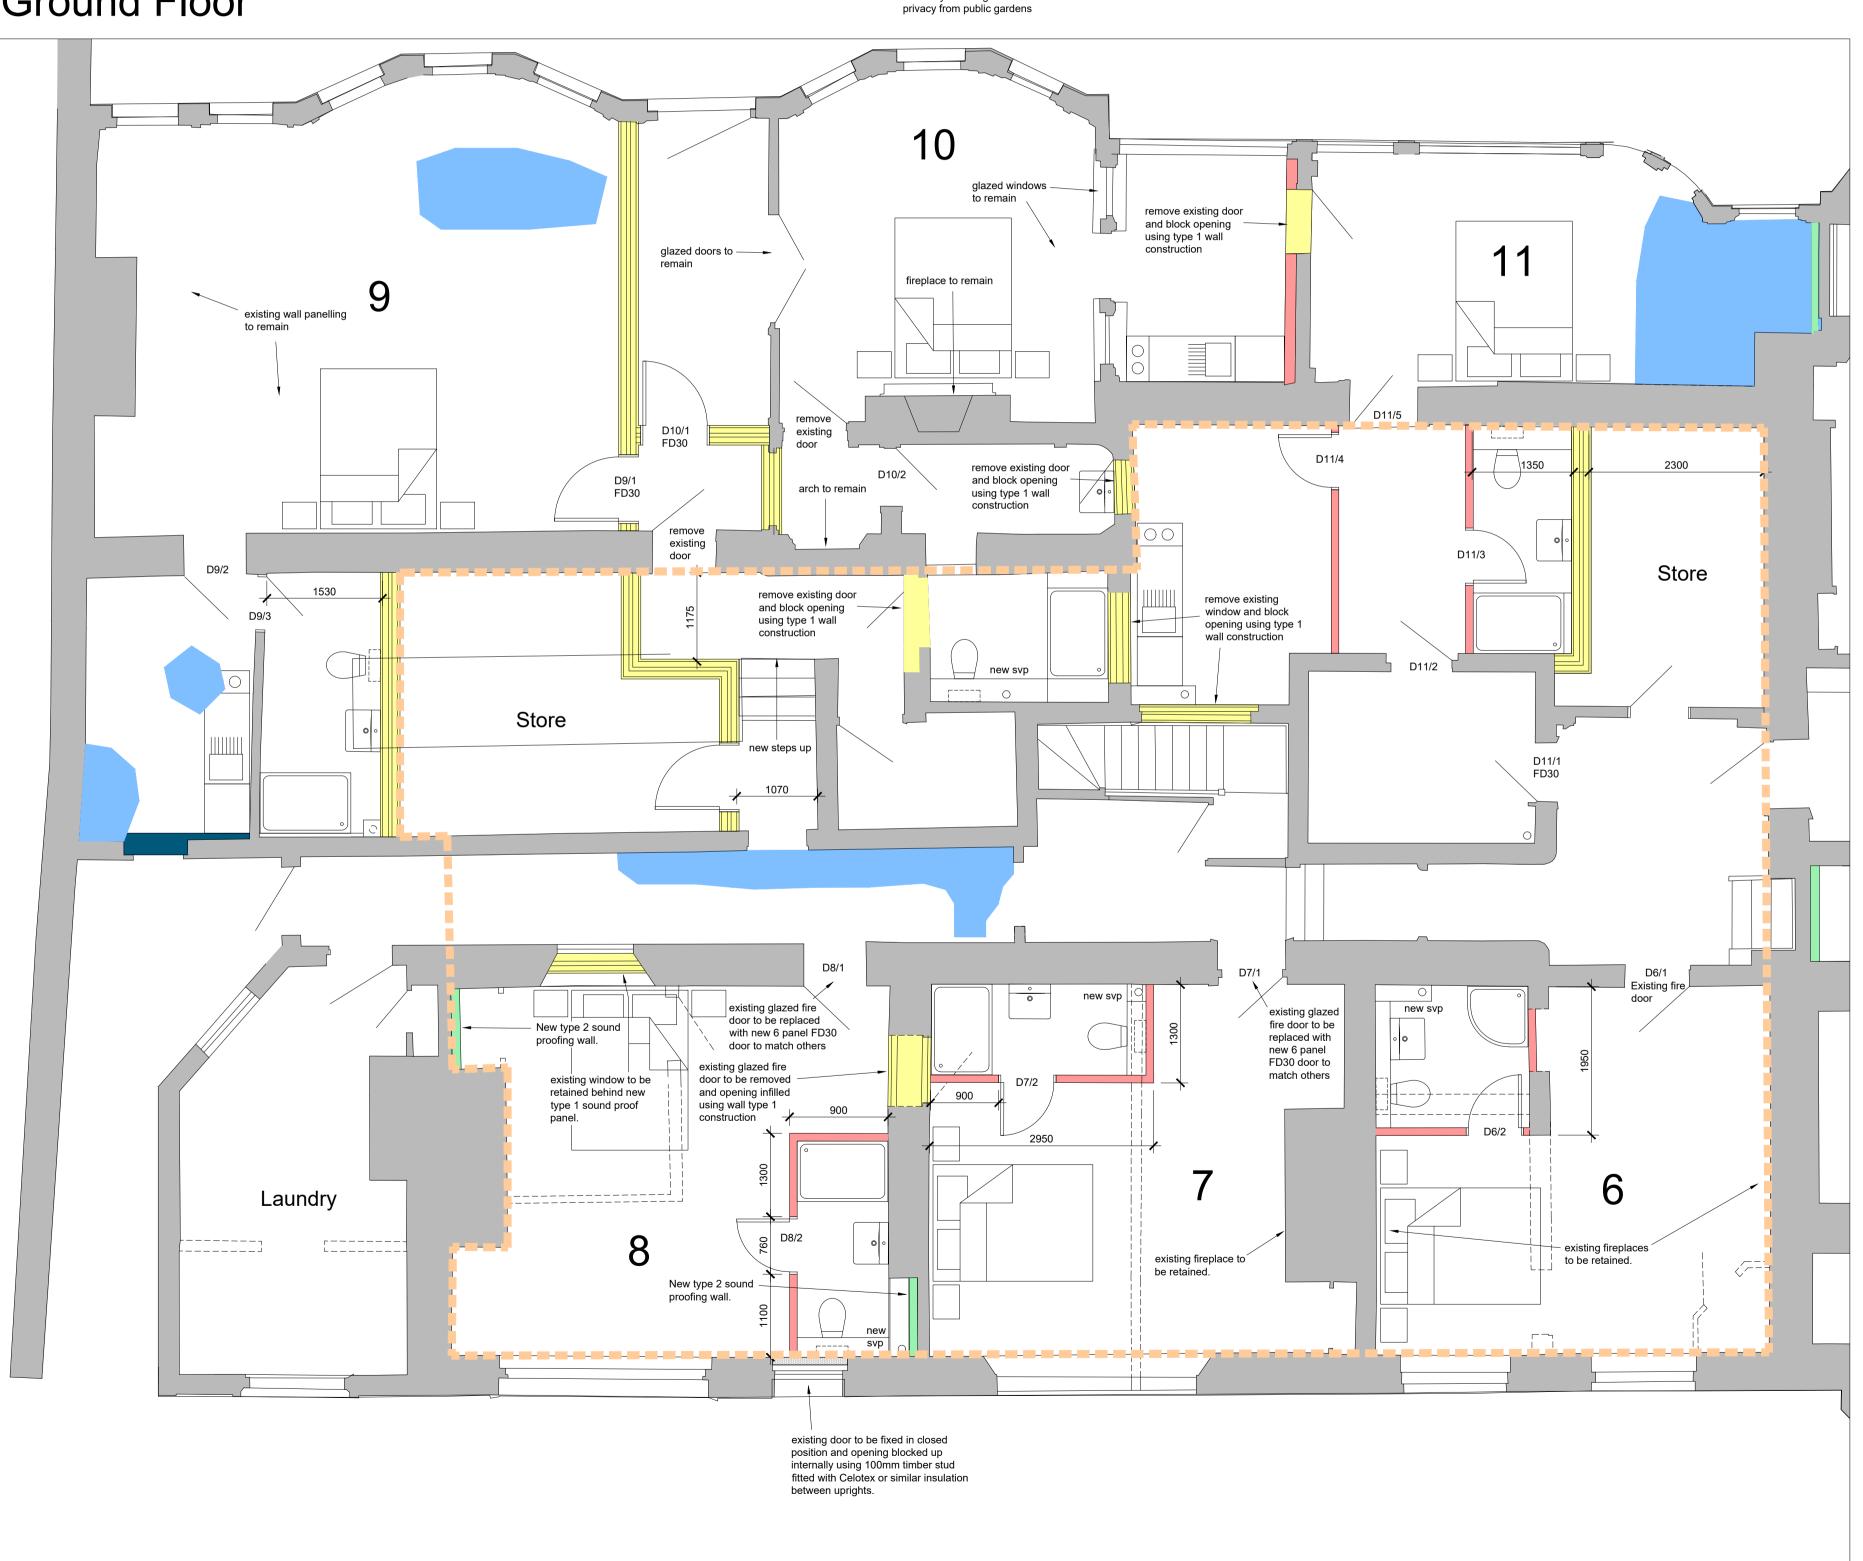


## Walls

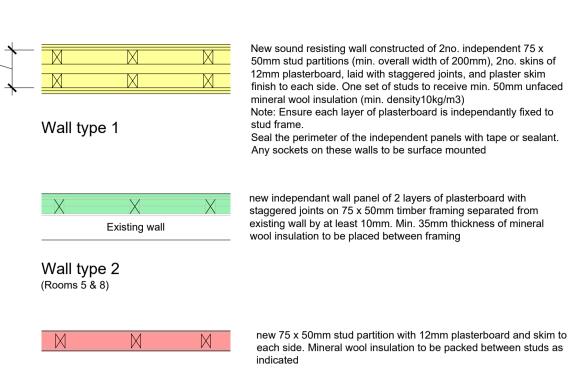

#### Wall type 3

## Ceilings

All ground floor areas to have suspended ceilings fitted, apart from bays as noted on plan. Existing ceilings/coving to be left untouched above.

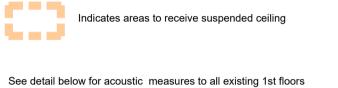

Indicates areas of existing ceilings badly damaged by water ingress which are to be repaired as follows, prior to fixing new suspended ceiling below.

 Hack off damaged plaster and underlying lathwork back to sound plaster, ensuring that laths are cut back to a structural support beam


2. Fix laths Oak Riven Laths allowing 25 no metre lengths per square metre.

3. Make sure surfaces are sound. Wet surfaces thoroughly. Dub out any large voids using Tradlym Mortar BM2. Allow dubbing out to cure.

4. First coat - Wet surface thoroughly. Apply 1st backing coat of Tradlym Backing with Hair/Fibre to a maximum depth of 10mm. If application is to laths sufficient mortar must be pushed through the lath to form "hooks" to take the weight of the remaining mortar. Allow to cure (up to 10 days) misting occasionally if plaster starts to dry out. Scratch to receive 2nd coat.

5. Second coat - Wet 1st coat. Apply 2nd coat of Tradlym Backing with Hair/Fibre and straighten up. Allow to cure again misting if necessary. Scratch with devil float.

6. Finish coat - Wet 2nd coat. Apply Tradlym Fine Finish plaster to a maximum depth of 4mm.

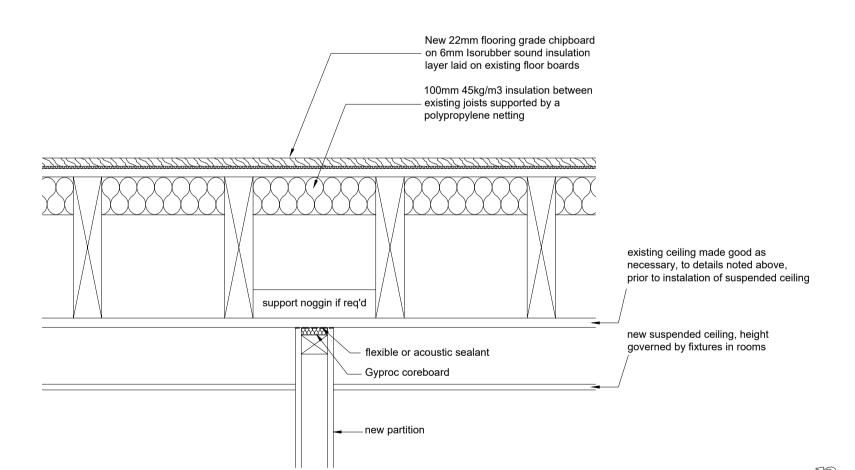

Scale 1:50 @ A1

## Section Through Existing First Floor




EDEN HOUSE, TWO RIVERS BUSINESS PARK, STATION LANE, WITNEY, OX28 4BL TEL. 01993 890760 FAX. 01993 779746

PROJECT:

CONVERSION OF OLD ABBEY HOUSE, ABINGDON

TITLE:


WORKING PLAN GROUND FLOOR (SHEET 2 OF 2)

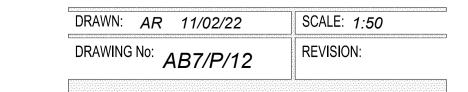



West Elevation

Rev C - 11/2/22 - Obscure glazing indicated on East elevation Rev B - 27/1/22 - Amendments made to North & East elevations Rev A - 8/7/21 - Rooflights added to West & East elevations

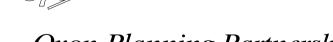

Oxon Planning Partnership
EDEN HOUSE, TWO RIVERS BUSINESS PARK, STATION LANE,
WITNEY, OX28 4BL TEL. 01993 890760 FAX. 01993 779746


WITNEY, OX28 4BL TEL. 01993 890760 FAX. 019
PROJECT:


CONVERSION OF OLD ABBEY HOUSE, ABINGDON

PROPOSED ELEVATIONS


DRAWN: AR 29/04/2021 | SCALE: 1:100

DRAWING No: AB7/P/04 | REVISION: C

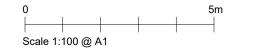

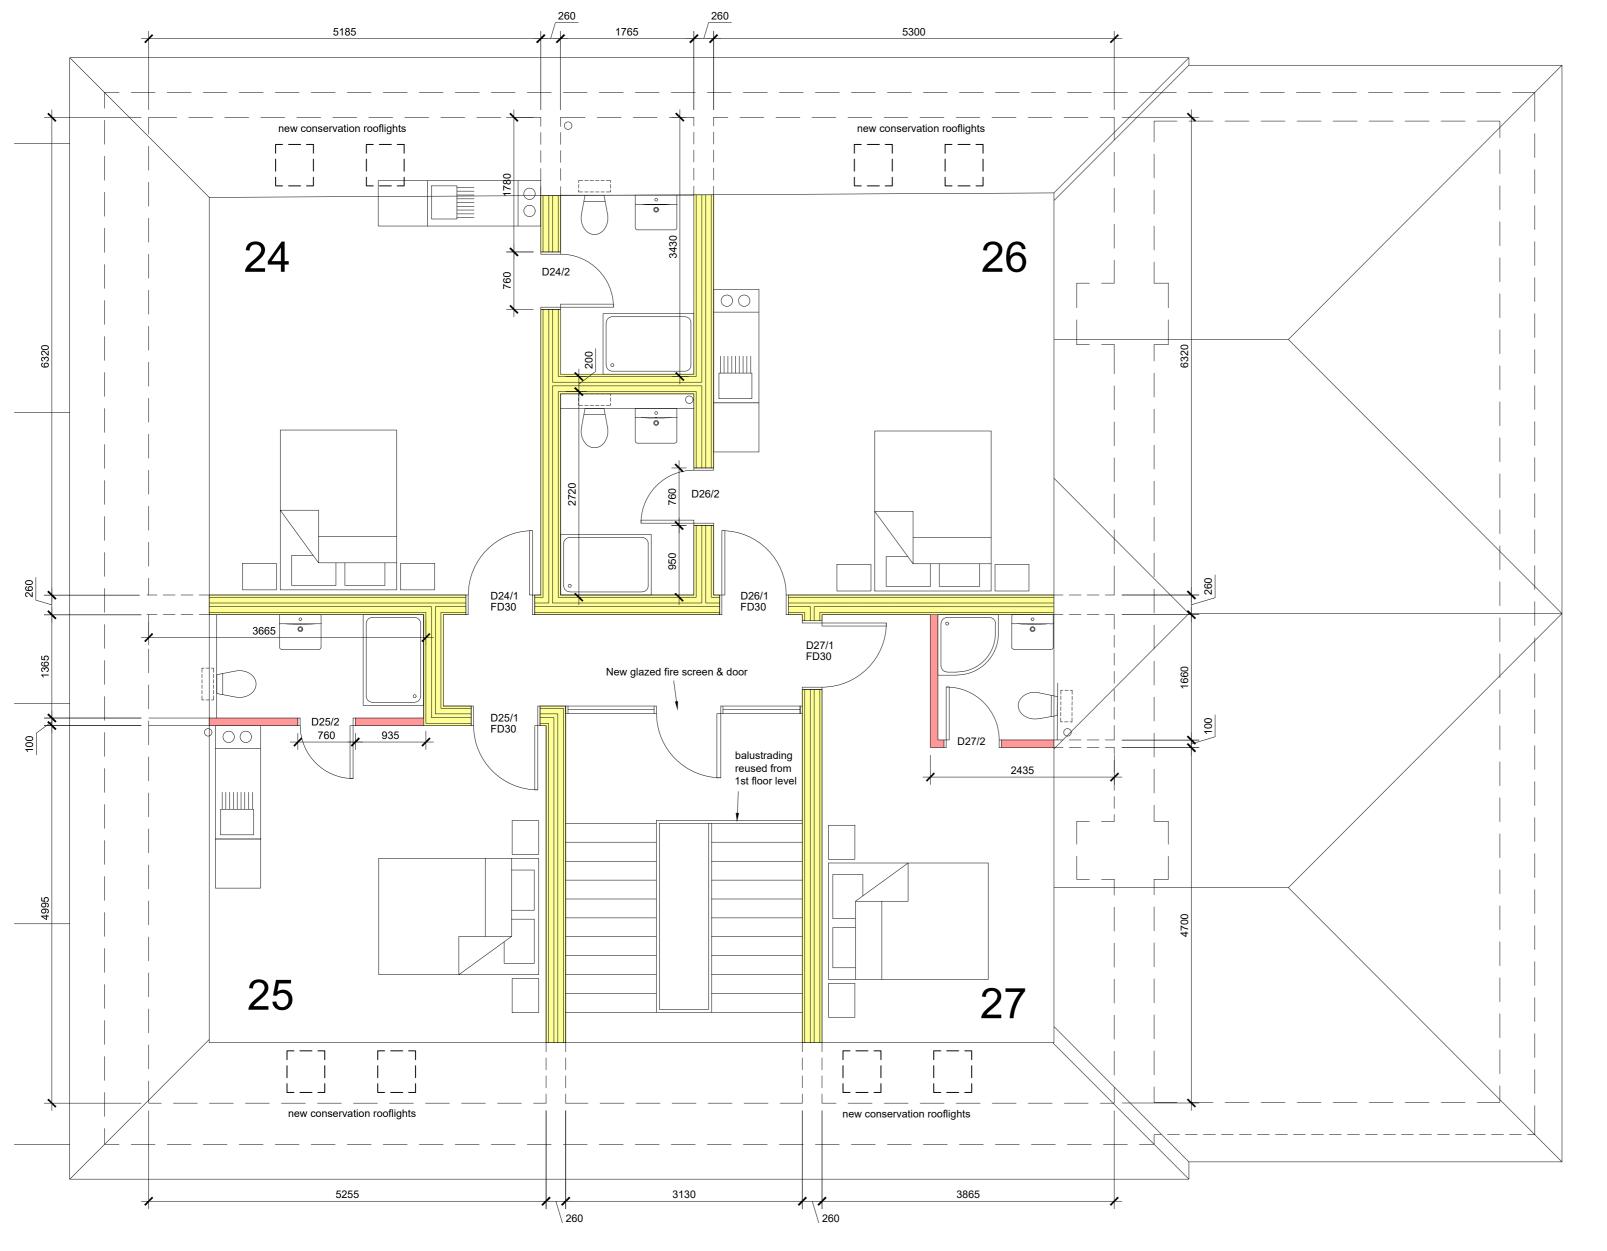

## Walls

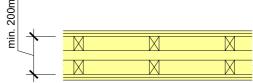

Wall type 1

New sound resisting wall constructed of 2no. independent 75 x 50mm stud partitions (min. overall width of 200mm), 2no. skins of 12mm plasterboard, laid with staggered joints, and plaster skim finish to each side. One set of studs to receive min. 50mm unfaced mineral wool insulation (min. density10kg/m3)
Note: Ensure each layer of plasterboard is independently fixed

Seal the perimeter of the independent panels with tape or

Any sockets on these walls to be surface mounted



new 75 x 50mm stud partition with 12mm plasterboard and skim to each side. Mineral wool insulation to be packed between studs as indicated

Wall type 3

Note: 150mm Kingspan K7 roofing insulation to be positioned between existing rafters at all sloping ceiling areas, underside of existing rafters to be battened out as necessary.

Ceiling to new flat roof area, formed between existing roofs, to receive min. 400mm fibreglass



### Oxon Planning Partnership

EDEN HOUSE, TWO RIVERS BUSINESS PARK, STATION LANE, WITNEY, OX28 4BL TEL. 01993 890760 FAX. 01993 779746

PROJECT:

CONVERSION OF OLD ABBEY HOUSE, ABINGDON

TITLE:

**WORKING PLAN** SECOND FLOOR

DRAWN: AR 11/02/22	SCALE: 1:50
DRAWING No: AB7/P/15	REVISION:

Scale 1:50 @ A2

